

NOTES:	NORTH					
c/w COMPLETE WITH FDN FOUNDATION e/w EACH WAY		DESIGN	ТМ	No.	REVISION DESCRIPTION	
EX. EXISTING H HIGH/HORIZONTAL		DRAWN	ТМ	1.	ISSUED FOR APPROVAL	
max. MAXIMUM min. MINIMUM	Y.	CHECKED	D MR	2.	LEACHING BED LOCATION	
OBC ONTARIO BUILDING CODE	- N	APPROVE	ED MR	3.	MUNICIPAL COMMENT	
P.T. PRESSURE TREATED		DATE	JUNE 2025	4.	ARMOUR STONE RETAININIG WALL DETAIL	
t/o TOP OF TYP. TYPICAL				5.	ISSUED FOR BUILDING PERMIT	
V VERTICAL						
W WIDE WWW WELDED WIRE MESH						



CONSULTANT

MM/DD/YY CH'KD

MR

MR

MR

MR

MR

03/17/25

03/27/25

04/28/25

05/01/25

06/05/25

9.8%

245.00

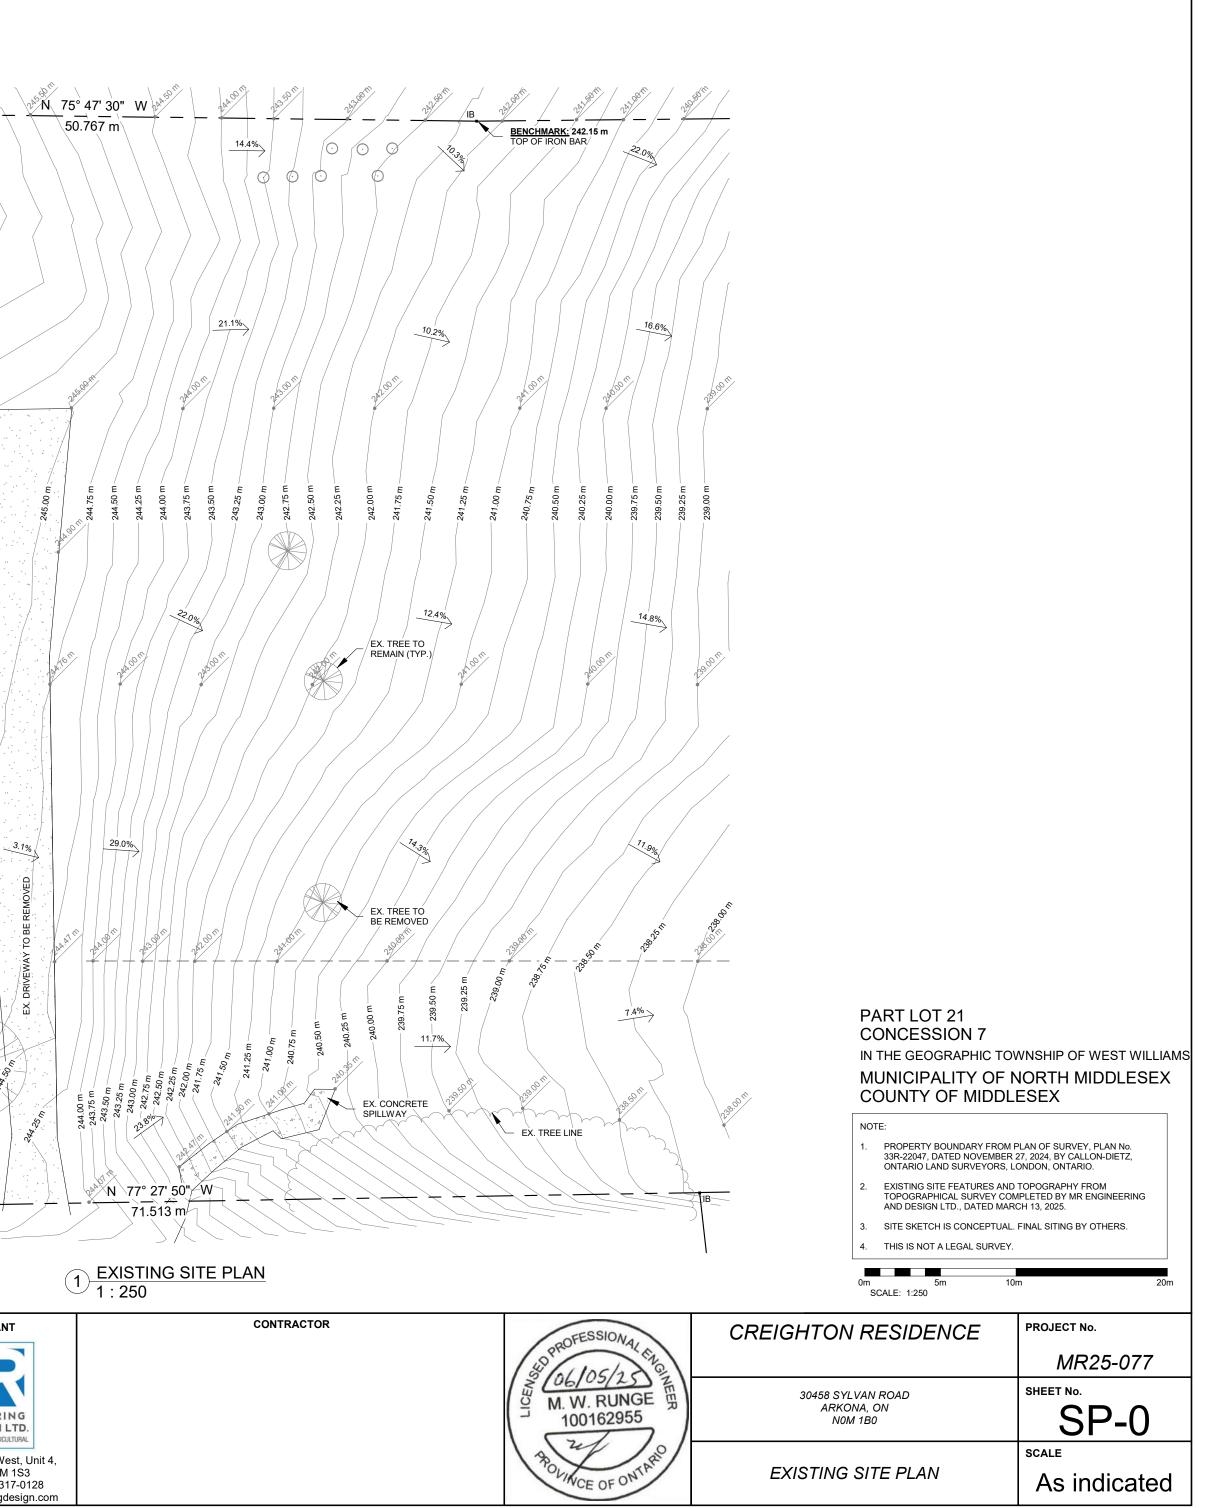
3.1%

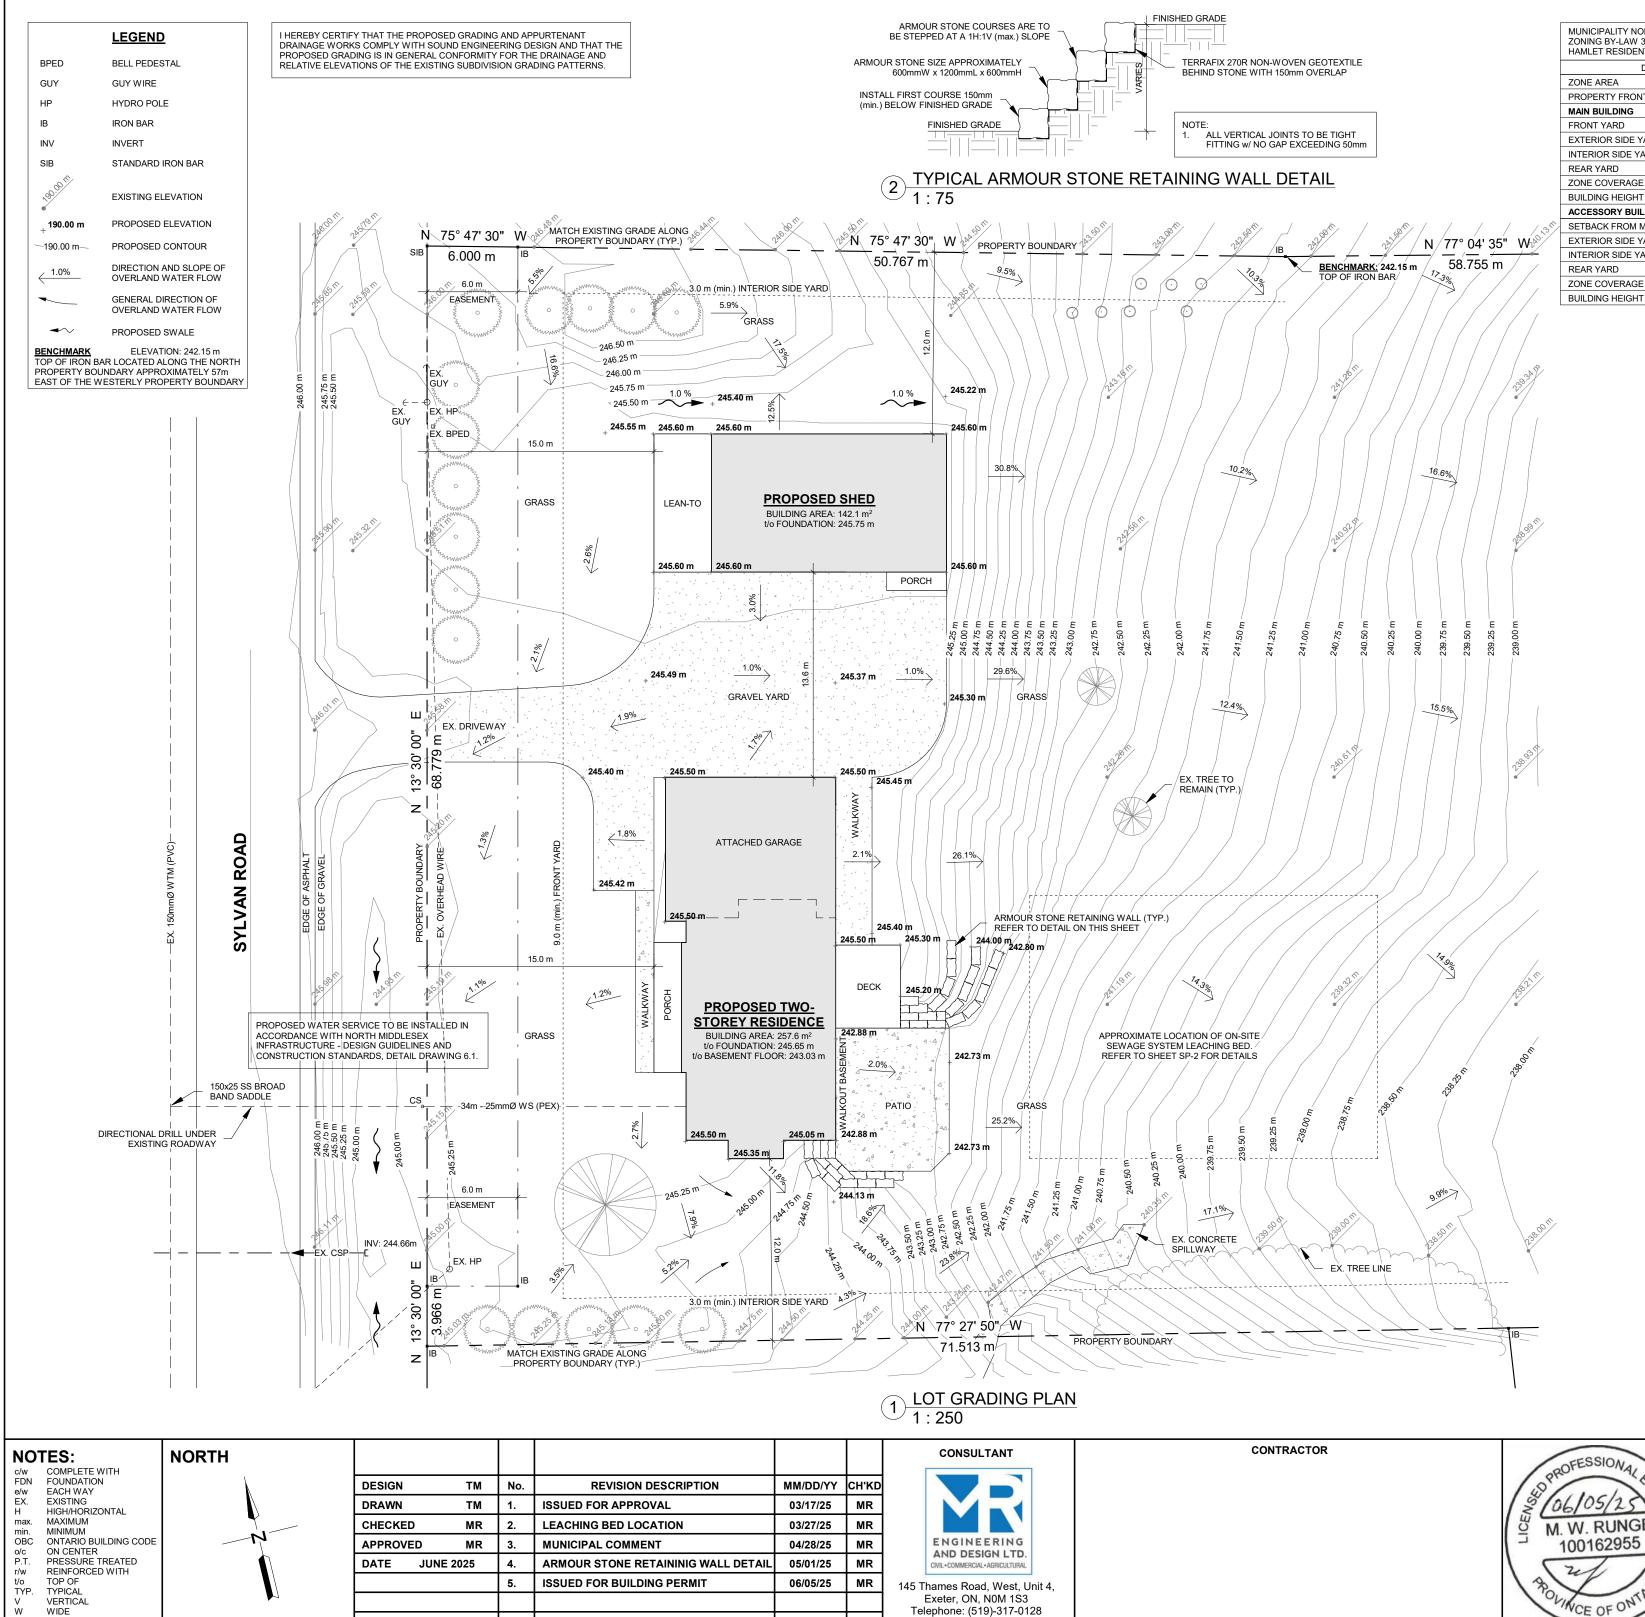
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2.700





Email: admin@mrengdesign.com

WIDE WWW WELDED WIRE MESH

MUNICIPALITY NORTH MIDDLESEX ZONING BY-LAW 35-2004 HAMLET RESIDENTIAL (RH) ZONE (SCHEDULE 'A' MAP 53) REQUIRED PROPOSED COMMENTS DETAIL ZONE AREA 1,500 m² (min.) 19,208.3 m² PROPERTY FRONTAGE 30.0 m (min.) 72.7 m MAIN BUILDING FRONT YARD 9.0 m (min.) 15.0 m EXTERIOR SIDE YARD 3.0 m (min.) N/A INTERIOR SIDE YARD 3.0 m (min.) 12.0 m REAR YARD 9.0 m (min.) 170.7 m ZONE COVERAGE 20 % (max.) 2.5 % ALL BUILDINGS GRADE AT FRONT TO MEAN ROOF SLOPE BUILDING HEIGHT 10.5 m (max.) 5.3 m ACCESSORY BUILDING SETBACK FROM MAIN BUILDING 1.5 m (min.) 13.6 m EXTERIOR SIDE YARD 3.0 m (min.) N/A INTERIOR SIDE YARD 1.5 m (min.) 12.0 m REAR YARD 1.5 m (min.) 167.4 m ZONE COVERAGE 10 % (max.) 0.9 % ACCESSORY ONLY

GENERAL NOTES:

6.3 m

5.5 m (max.)

ALL EXTERIOR LIGHTING TO BE CONFINED TO THE BUILDING FACE AND PARKING AREAS SO AS NOT TO CAST A GLARE ONTO THE STREET OR ADJACENT PROPERTIES.

AVERAGE GRADE TO ROOF PEAK

SEDIMENT AND EROSION CONTROL:

- PROTECT ALL EXPOSED SURFACES AND CONTROL ALL RUNOFF DURING CONSTRUCTION. PROTECT ALL CATCH BASINS, MANHOLES AND PIPE ENDS FROM SEDIMENT INTRUSION WITH GEOTEXTILE FABRIC (OR EQUAL).
- SEDIMENT AND EROSION CONTROL MEASURES TO BE IN ACCORDANCE 2. WITH THE MINISTRY OF NATURAL RESOURCES GUIDELINES ON EROSION AND SEDIMENT CONTROL FOR URBAN CONSTRUCTION SITES.

DRAINAGE NOTES:

- ALL FINISHED GRADES TO DIRECT OVERLAND WATER FLOW AWAY FROM ALL STRUCTURES LOCATED ON-SITE
- 2. PROVIDE SPLASH PADS (OR EQUAL) FOR ALL EAVES TROUGH DOWN SPOUTS THAT DISCHARGE AT GRADE.

WATER SERVICE:

- PRIOR TO CONSTRUCTION, THE CONTRACTOR MUST CHECK AND VERIFY ALL EXISTING CONDITIONS. LOCATIONS AND ELEVATIONS. REPORT ALL DISCREPANCIES TO THE ENGINEER PRIOR TO PROCEEDING.
- THE LOCATIONS OF ALL EXISTING UNDERGROUND UTILITIES ARE 2. APPROXIMATE THE CONTRACTOR IS TO OBTAIN ALL UTILITY LOCATES NOT ALL EXISTING UTILITIES WITHIN THE RIGHT-OF-WAY MAY BE SHOWN
- 3. ALL WORKS ON THE MUNICIPAL RIGHT-OF-WAY TO BE APPROVED BY THE MUNICIPALITY AND LOCAL ROADS AUTHORITY. THE CONTRACTOR IS RESPONSIBLE FOR THE RESTORATION OF ALL BOULEVARD AREAS.
- CONTRACTOR TO PROVIDE TRAFFIC CONTROL MEASURES IN COMPLIANCE WITH THE ONTARIO TRAFFIC MANUAL BOOK 7 (LATEST EDITION) FOR ALL WORKS WITHIN THE MUNICIPAL RIGHT-OF-WAY. CONTRACTOR TO SUBMIT TRAFFIC CONTROL PLANS TO THE MUNICIPALITY/ENGINEER FOR REVIEW PRIOR TO COMMENCING WITH CONSTRUCTION.
- 5. WATER SERVICE CONNECTION SHALL BE CROSS-LINKED POLYETHYLENE (PEX) POTABLE WATER SERVICE TUBING IN ACCORDANCE WITH AWWA C904 ASTM F876-05, ASTM877-05, CSA-B137.5 AND NSF 61 WITH 12 GAUGE TRACER WIRE
- 6. PIPE BEDDING FOR RIGID PIPE TO BE CLASS "B" AS PER OPSD 802.030, 802.031, OR 802.032. PIPE BEDDING FOR FLEXIBLE PIPE TO BE AS PER OPSD 802.010. COVER MATERIAL TO BE GRANULAR "A" PLACED IN 300mm LIFTS AND COMPACTED TO 95% STANDARD PROCTOR DRY DENSITY.
- SERVICE SADDLE FOR PIPE DIAMETERS LESS THAN 100mm SHALL BE ROBAR 7. 2600 SERIES SERVICE SADDLE WITH T-304 STAINLESS STEEL BOLTS (OR EQUAL). SINGLE LENGTH PIPE FROM MAIN TO CURB STOP AT PROPERTY LINE.
- 8. MAIN STOPS, CURB STOPS AND COUPLINGS SHALL BE AWWA C-800 COPPER TO COPPER FLANGED OR COMPRESSION CONNECTION OR APPROVED EQUIVALENT
- INSULATE WATERMAINS AND SERVICES AS PER OPSD 1109.030 WHERE 1.7m 9. COVER CANNOT BE ACHIEVED.
- 10. WATER SERVICE TO BE SEPARATED FROM SANITARY/STORM SEWER BY 2.44n (min.). CROSSINGS TO BE IN ACCORDANCE WITH THE LATEST EDITION OF THE M.O.E. "DESIGN GUIDELINES FOR DRINKING WATER SYSTEMS".
- 11. ALL UNDERGROUND SERVICES ARE TO BE CONSTRUCTED IN COMPLIANCE WITH THE LATEST EDITION OF THE ONTARIO BUILDING CODE (2012), (PART 7 -PLUMBING), THE PROVINCIAL STANDARD SPECIFICATIONS (OPSD), AND LOCAL REGULATIONS.

PART LOT 21

CONCESSION 7

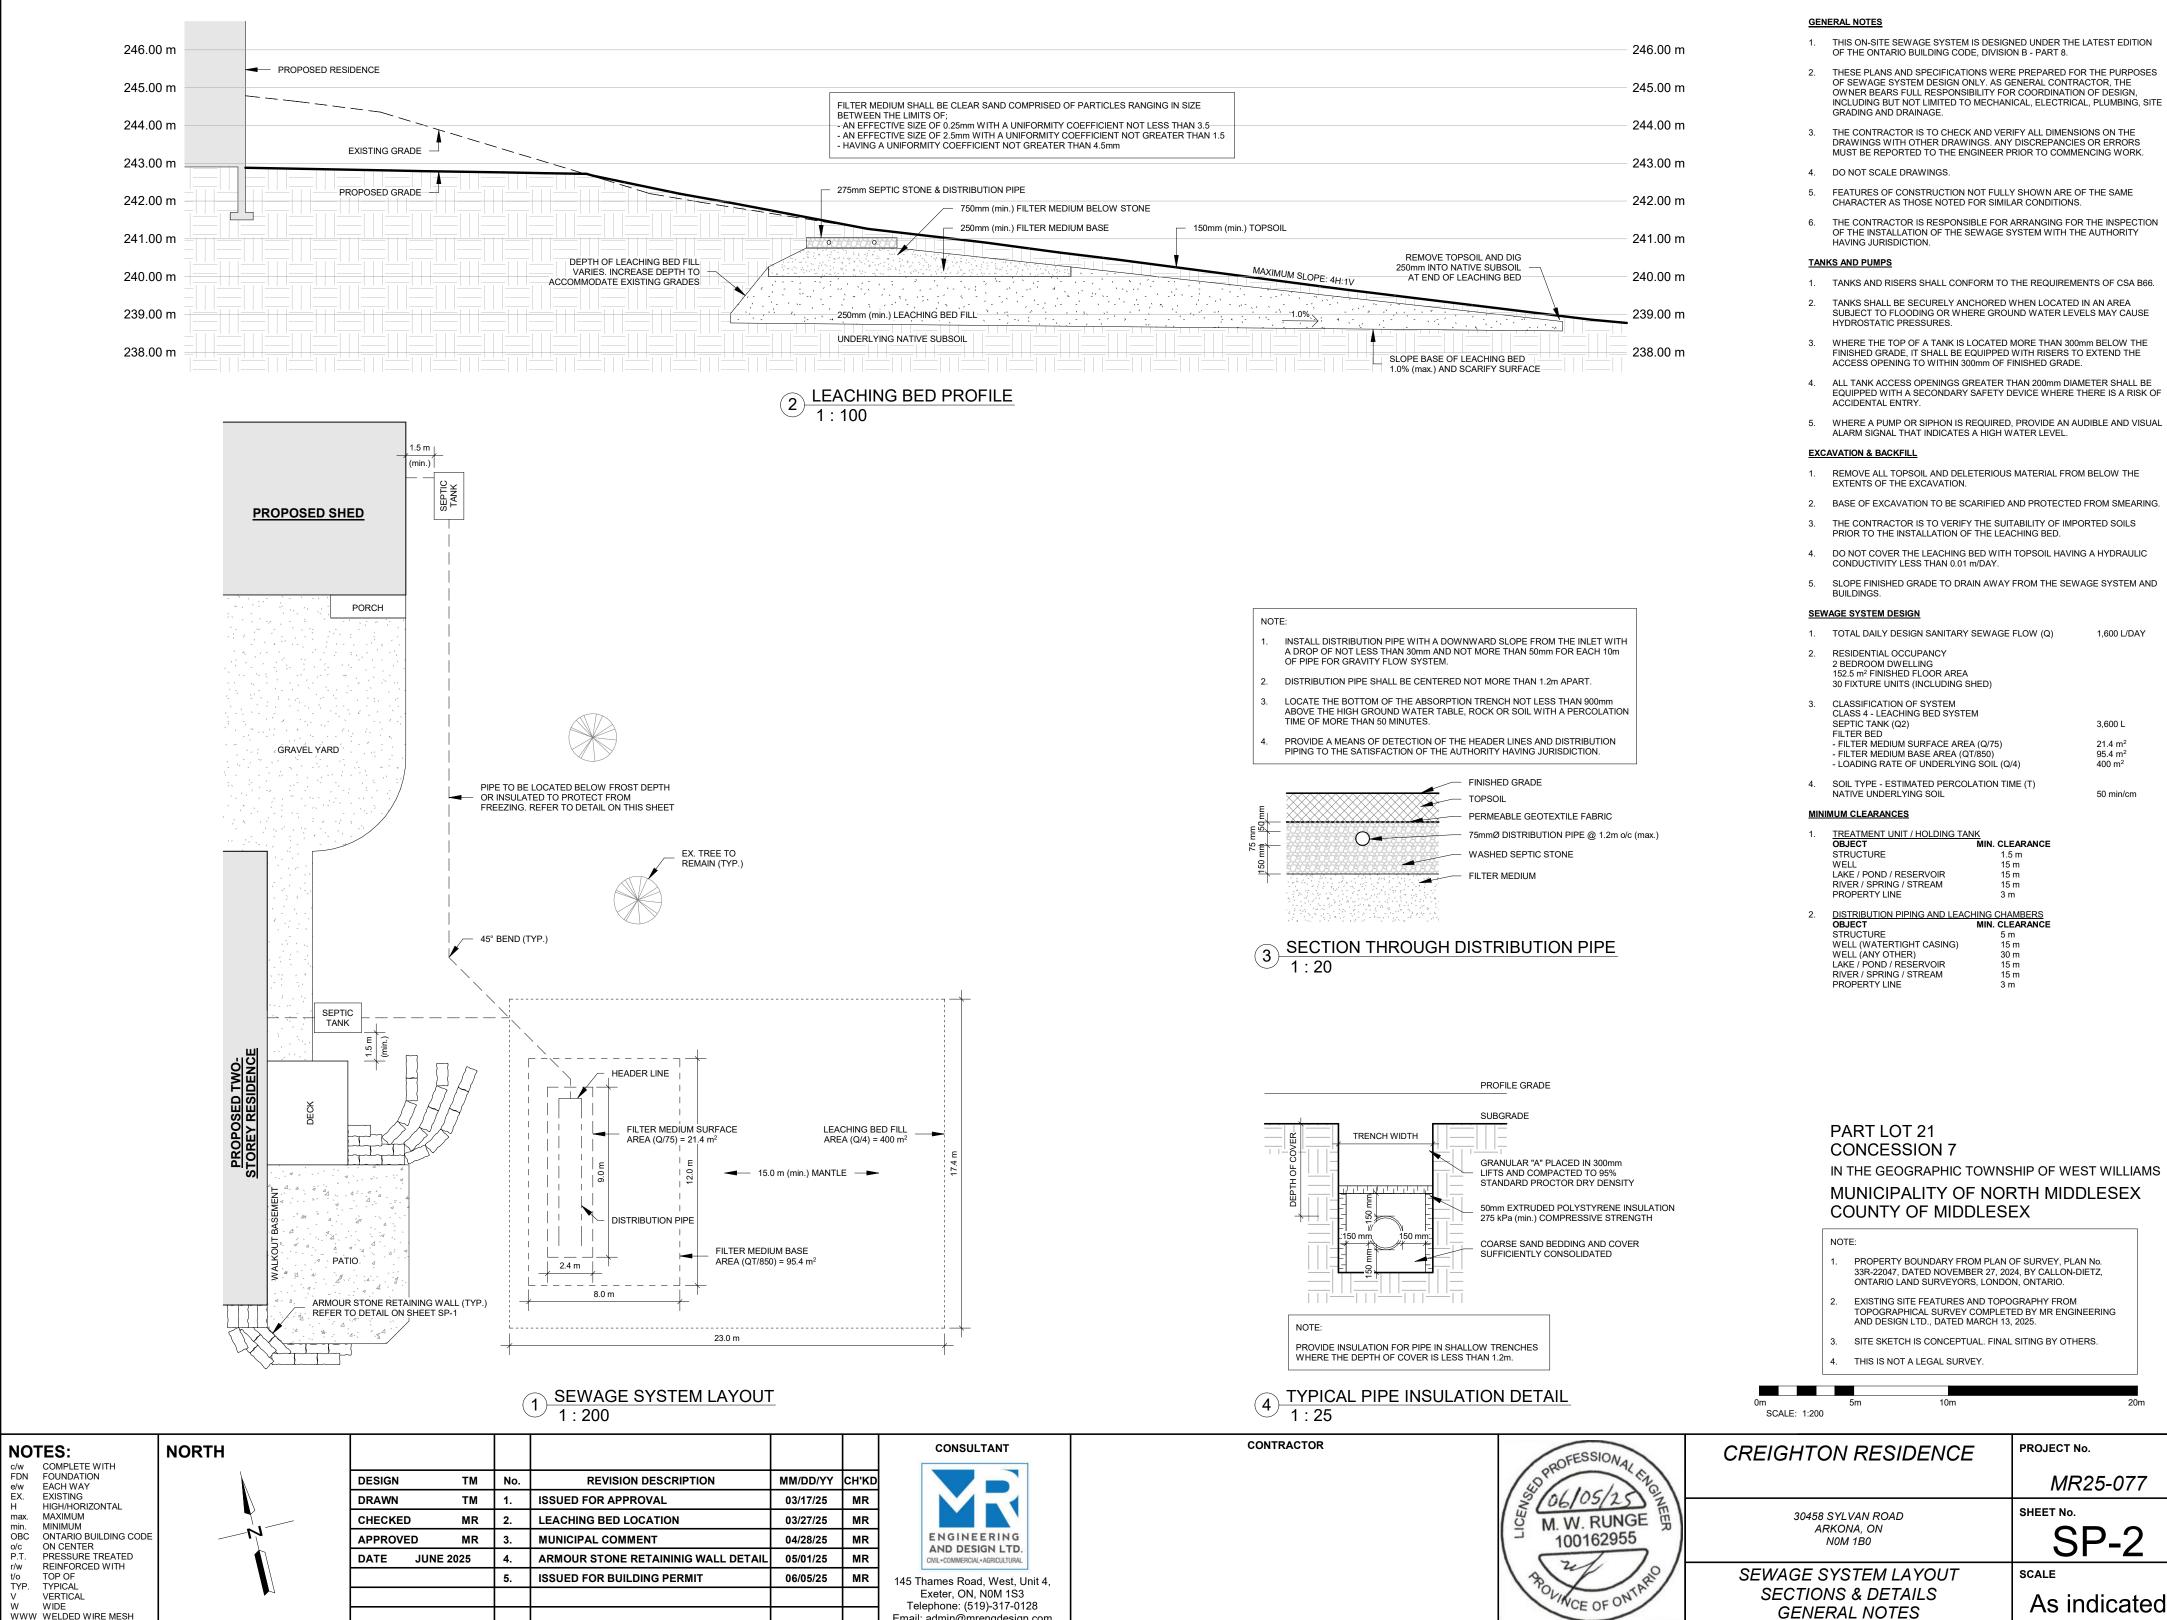
IN THE GEOGRAPHIC TOWNSHIP OF WEST WILLIAMS MUNICIPALITY OF NORTH MIDDLESEX COUNTY OF MIDDLESEX

NOTE:

- PROPERTY BOUNDARY FROM PLAN OF SURVEY, PLAN No. 33R-22047, DATED NOVEMBER 27, 2024, BY CALLON-DIETZ, ONTARIO LAND SURVEYORS, LONDON, ONTARIO.
- EXISTING SITE FEATURES AND TOPOGRAPHY FROM TOPOGRAPHICAL SURVEY COMPLETED BY MR ENGINEERING AND DESIGN LTD., DATED MARCH 13, 2025.
- SITE SKETCH IS CONCEPTUAL. FINAL SITING BY OTHERS. THIS IS NOT A LEGAL SURVEY.

SCALE: 1:250

TOR	OFESSIONA	CREIGHTON RESIDENCE	PROJECT No.
	2 PRO LINCH PRO		MR25-077
	M. W. RUNGE H 100162955	30458 SYLVAN ROAD ARKONA, ON NOM 1B0	SHEET NO. SP-1
	BOLINCE OF ONTAR	LOT GRADING PLAN	scale As indicated



Email: admin@mrengdesign.com

WWW WELDED WIRE MESH